

Proposed New Residence for:

Benjamin & Ann Good Bear Valley Road Fort Loudon, PA 17224

Franklin County, PA

GENERAL NOTES

1) ALL EXTERIOR WALLS TO BE 2X6 CONSTRUCTION W/MIN. $\%_6$ " OSB SHEATHING, UNLESS NOTED OTHERWISE.

2) ALL INTERIOR WALLS TO BE 2X4 CONSTRUCTION, UNLESS NOTED OTHERWISE.

3) ALL WINDOWS AND DOORS TO MEET LOCAL REQUIREMENTS FOR U VALUE AND ALL OTHER ENERGY

4) ALL CONSTRUCTION TO BE COMPLETED IN COMPLIANCE WITH CURRENT IRC CODE AND LOCAL

GOVERNING BUILDING AND INSPECTIONS DEPARTMENT.

5) ALL MECHANICAL WORK MUST BE DONE IN

COMPLIANCE WITH CURRENT IRC CODE AND LOCAL GOVERNING BUILDING AND INSPECTIONS DEPARTMENT.

6) ALL PLUMBING WORK MUST BE DONE IN COMPLIANCE WITH CURRENT IRC CODE AND LOCAL GOVERNING BUILDING AND INSPECTIONS DEPARTMENT.

7) ALL ELECTRICAL WORK MUST BE DONE IN COMPLIANCE WITH CURRENT IRC CODE AND LOCAL GOVERNING BUILDING AND INSPECTIONS DEPARTMENT.

8) ALL EXTERIOR DIMENSIONS TO WOOD ARE TO SHEATHING LINE. INTERIOR DIMENSIONS ARE TO FRAME LINE.

INSULATION NOTES

ENTIRE STRUCTURE TO BE FULLY INSULATED TO MEET CURRENT IRC ENERGY CODE REQUIREMENTS.
 ALL EXTERIOR WALLS TO BE INSULATED WITH

3) ALL ROOF / CEILING OVER DWELLING UNIT TO BE INSULATED WITH MIN. R-38.

NOTE: VARIATIONS TO R-VALUES MAY BE MADE AS PERMITTED BY CODE OFFICIAL.

Area Calculations

Basement Level Living Space 1,808 SF (including studio and unfinished area)

1st Level Living Space 1,462 SF (excludes studio)

2nd Level Living Space 756 SF (includes storage area)

Porches 156 SF

Drawing Index

- A-1 Exterior Elevations
- A-2 Basement Floor Plan
- A-3 1st Level Floor Plan
- A-4 2nd Level Floor Plan A-5 Section Views
- A-6 Section Views

 A-6 Section Views

 A-6 Section Views
- A-7 Section View, Section View Details
- S-1 Foundation Plan
- S-2 1st Level Floor Framing Plan
- S-3 2nd Level Floor Framing Plan
- S-4 Roof Framing Plan

Code & Design Criteria

Building Code

IRC 2009

Design Loads for New Construction

<u>Floor</u> Live Load

Live Load 40 PSF Dead Load 12 PSF

Roof

Construction Live Load 35 PSF Snow Load 30 PSF Dead Load 20 PSF

Live Load Minimum Deflection Criteria

Floor JoistsL / 480Floor BeamsL / 360RoofL / 360Roof BeamsL / 360



Sheet Number


CS

10-17-16

CONTRACTOR IS RESPONSIBLE TO VERIFY ALL INFORMATION CONTAINED IN THESE PLANS PRIOR TO CONSTRUCTION AND ASSUMES FULL LIABILTY FOR THE CONSTRUCTION OF THIS PROJECT. DESIGNER IS NOT RESPONSIBLE FOR ANY PROBLEMS RESULTING FROM UNAUTHORIZED CHANGES TO THESE PLANS. CONSTRUCTION OF THIS PROJECT MUST BE DONE IN ACCORDANCE WITH CURRENT LOCAL APPLICABLE BUILDING CODES. ANY DISCREPANCIES FOUND IN THIS DRAWING SET SHOULD BE FORWARDED TO BUILDING DESIGNER. USE OF THESE PLANS FOR CONSTRUCTION OF ANY PROJECT OTHER THAN THAT SPECIFIED IS NOT ALLOWED.





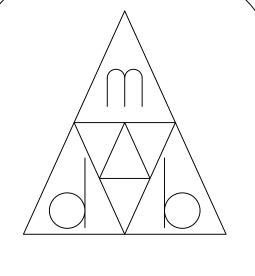

21153 main street shade gap, pa 17255 (814) 421-6233 www.mdbhouseplans.com

Client

Benjamin & Ann Good 14 Village Lane Harrisonville, PA 17228

<u>Project</u>

New Residence Benjamin & Ann Good Bear Valley Road Fort Loudon, PA 17224

Drawing


Exterior Elevations


Sheet Number

A-1





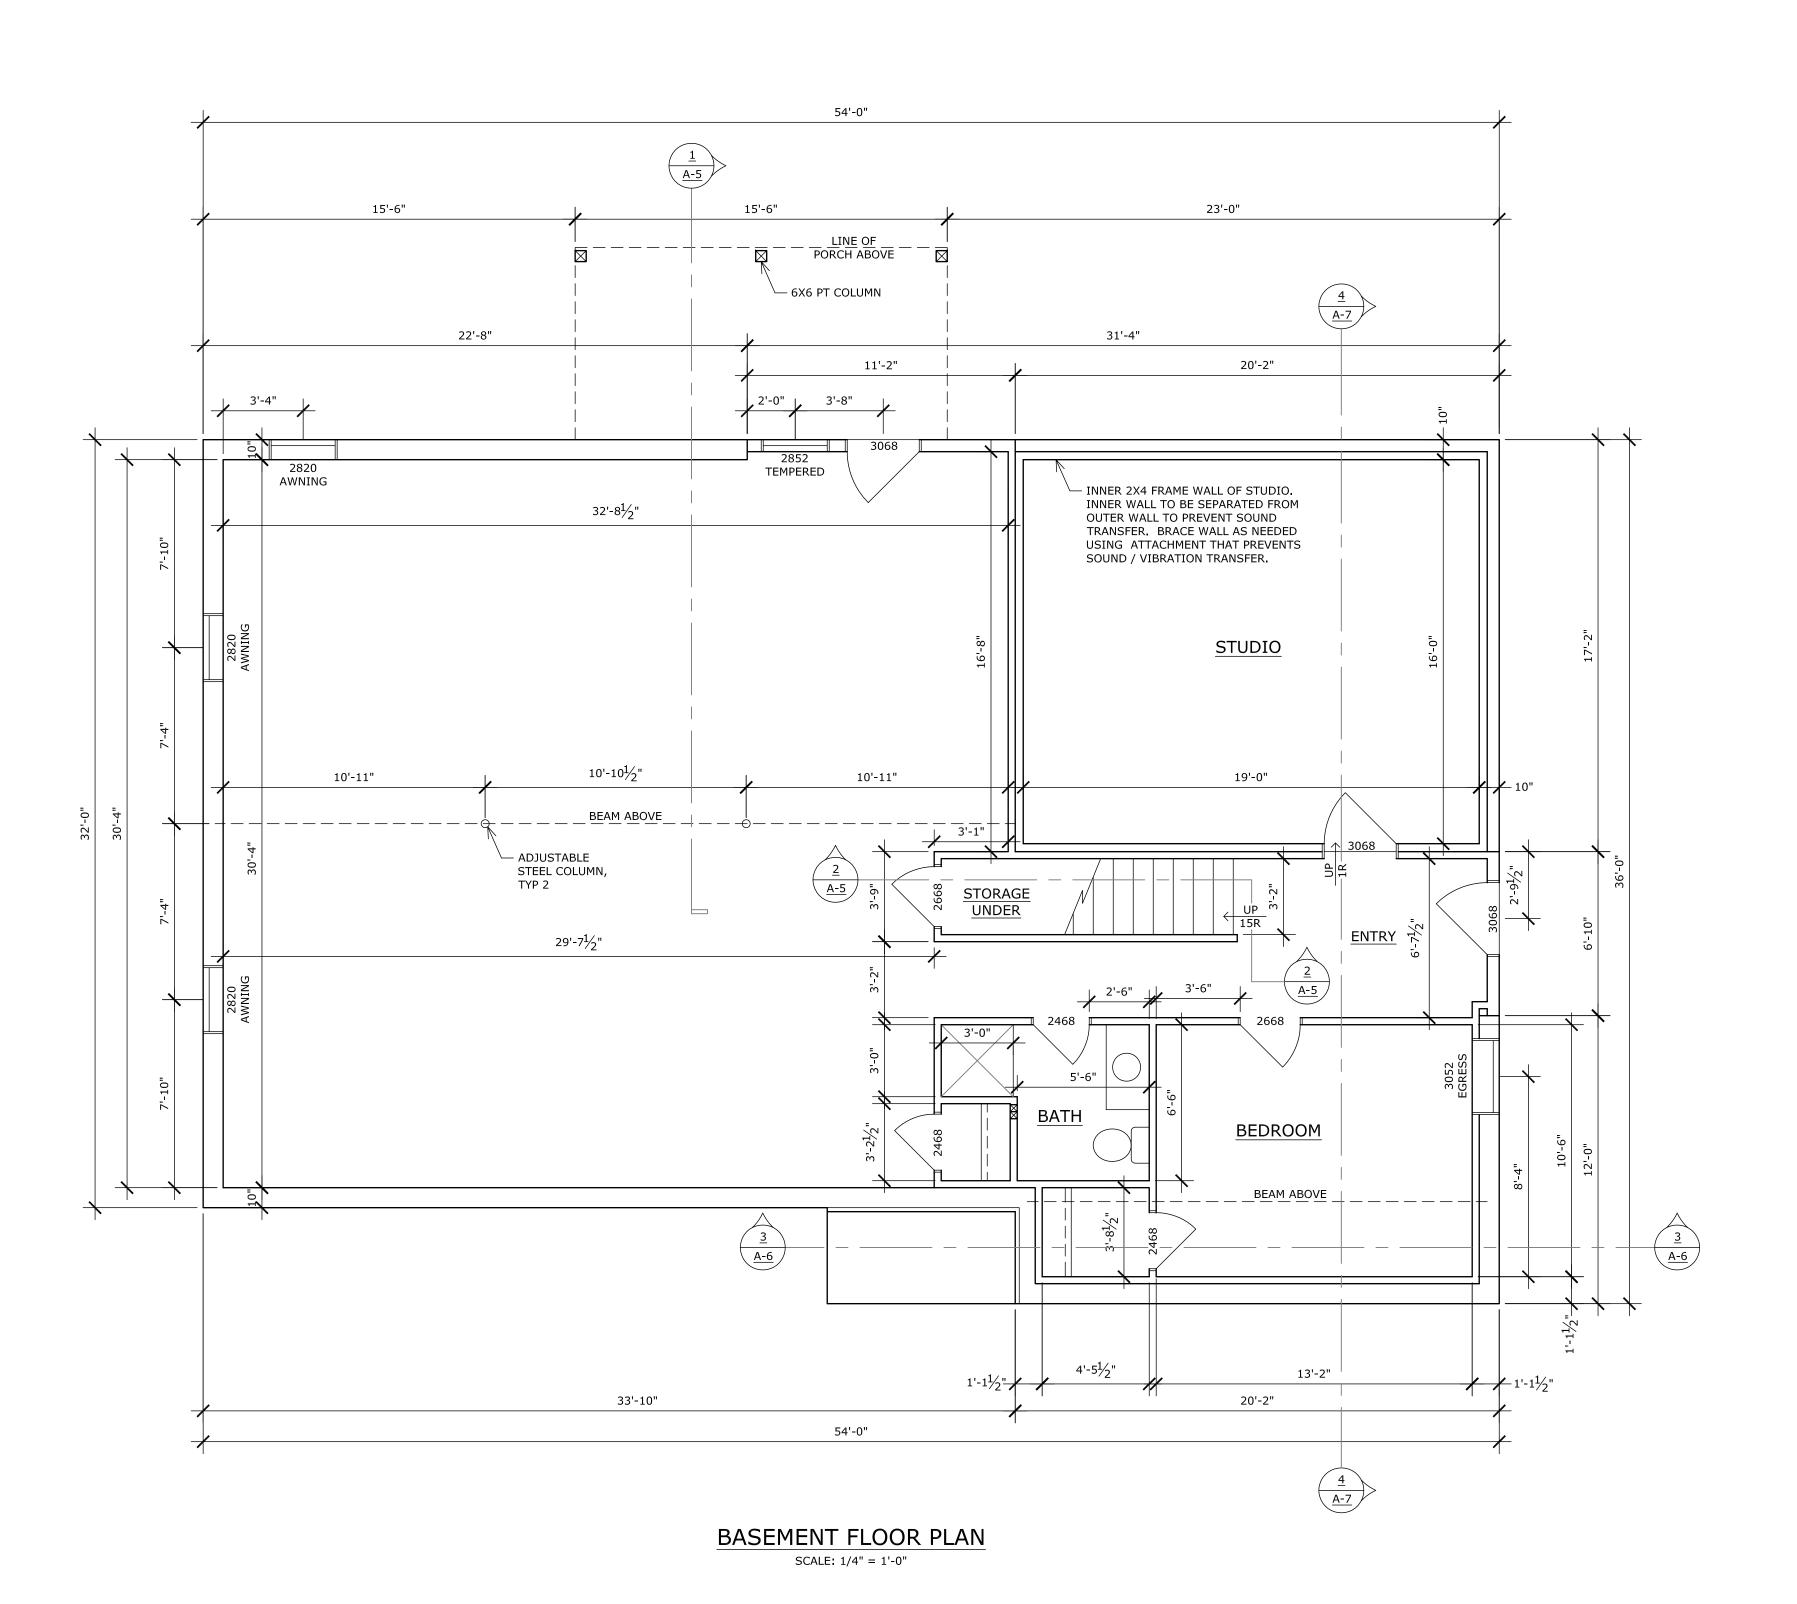

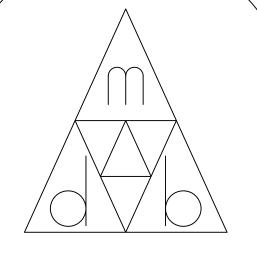

21153 main street shade gap, pa 17255 (814) 421-6233 www.mdbhouseplans.com

Client

Benjamin & Ann Good 14 Village Lane Harrisonville, PA 17228

Project


New Residence Benjamin & Ann Good Bear Valley Road Fort Loudon, PA 17224

Drawing

Basement Floor Plan


Sheet Number

A-2

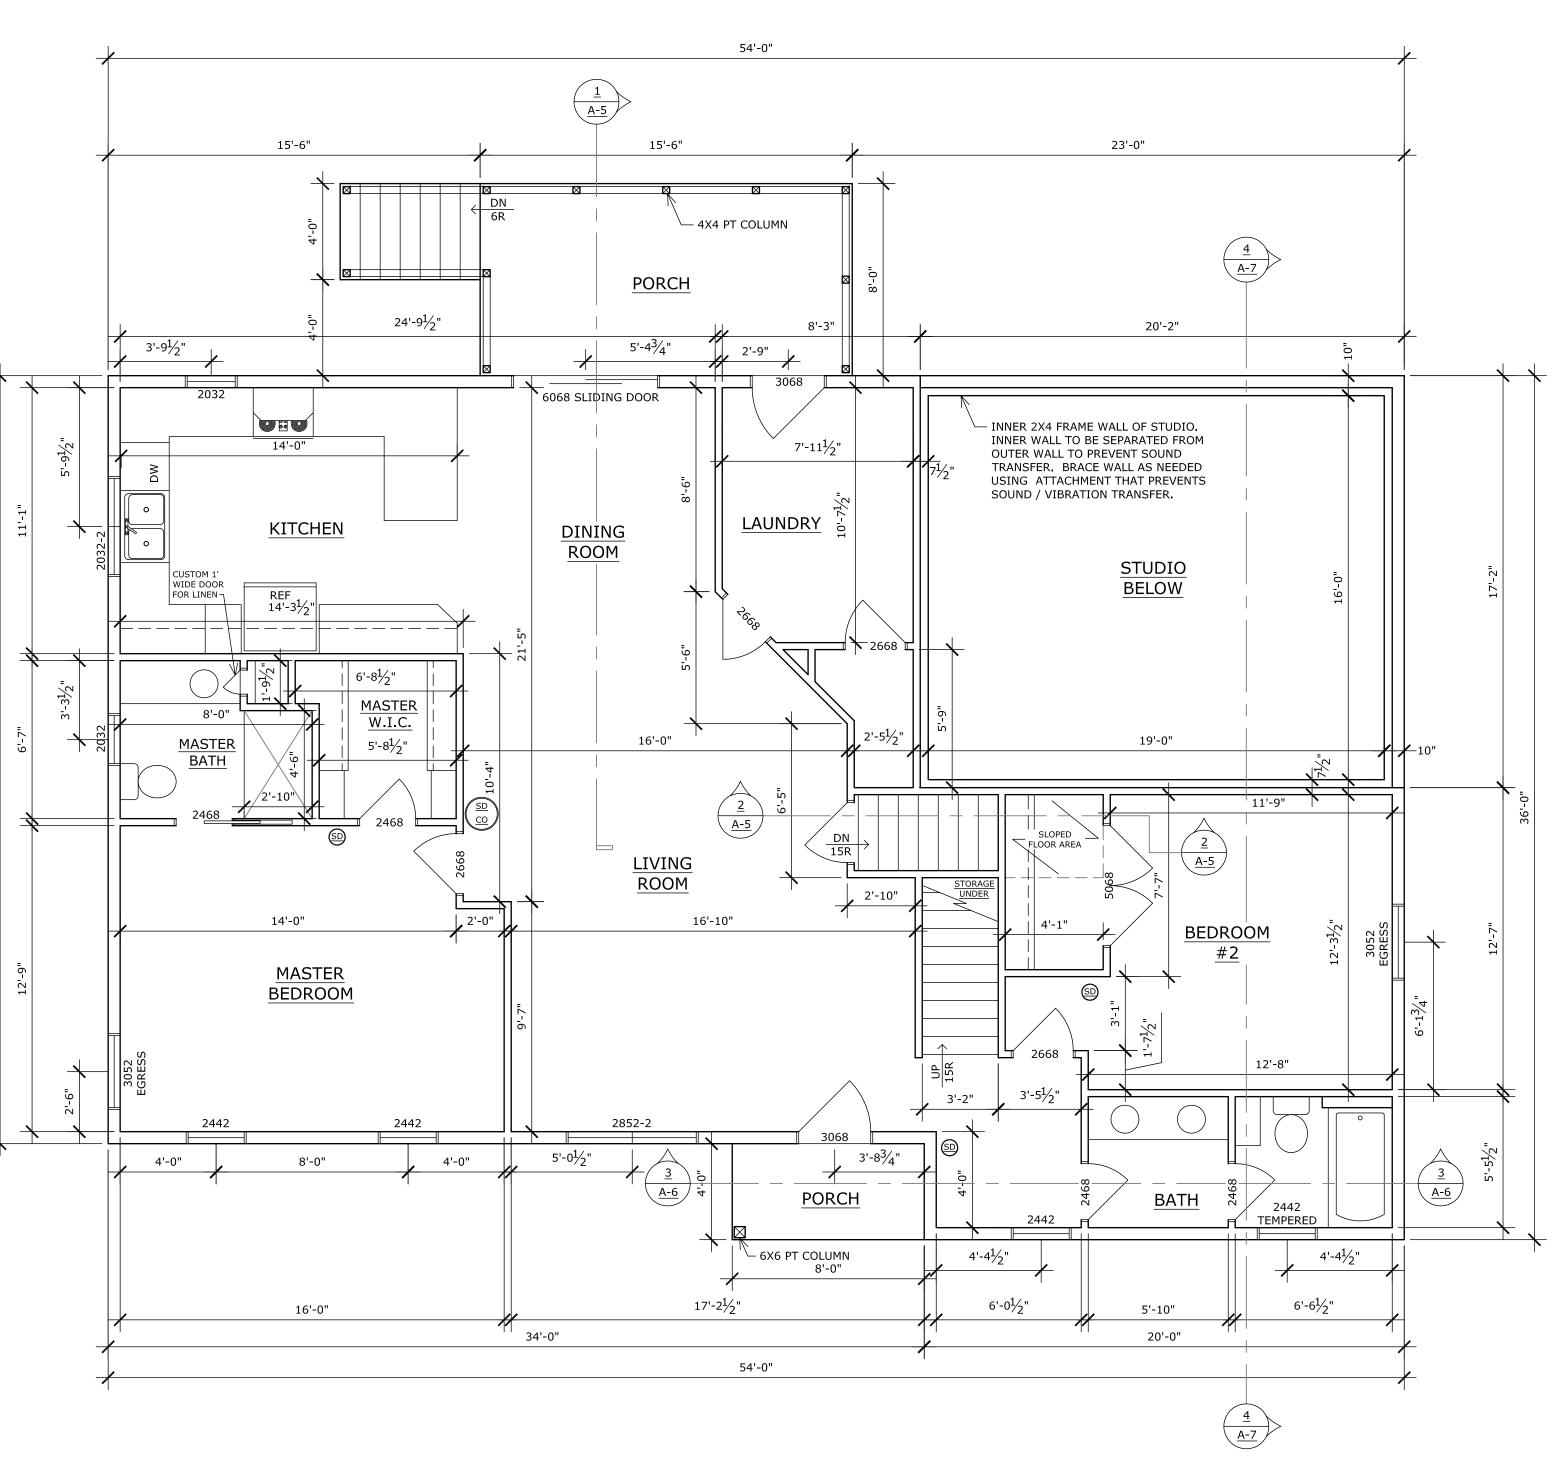

1ST LEVEL FLOOR PLAN

SCALE: 1/4" = 1'-0"

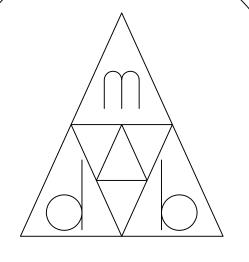

mdb drafting & design

21153 main street shade gap, pa 17255 (814) 421-6233 www.mdbhouseplans.com

Client

Benjamin & Ann Good 14 Village Lane Harrisonville, PA 17228

Project


New Residence Benjamin & Ann Good Bear Valley Road Fort Loudon, PA 17224


Drawing

1st Level Floor Plan

Sheet Number

A-3

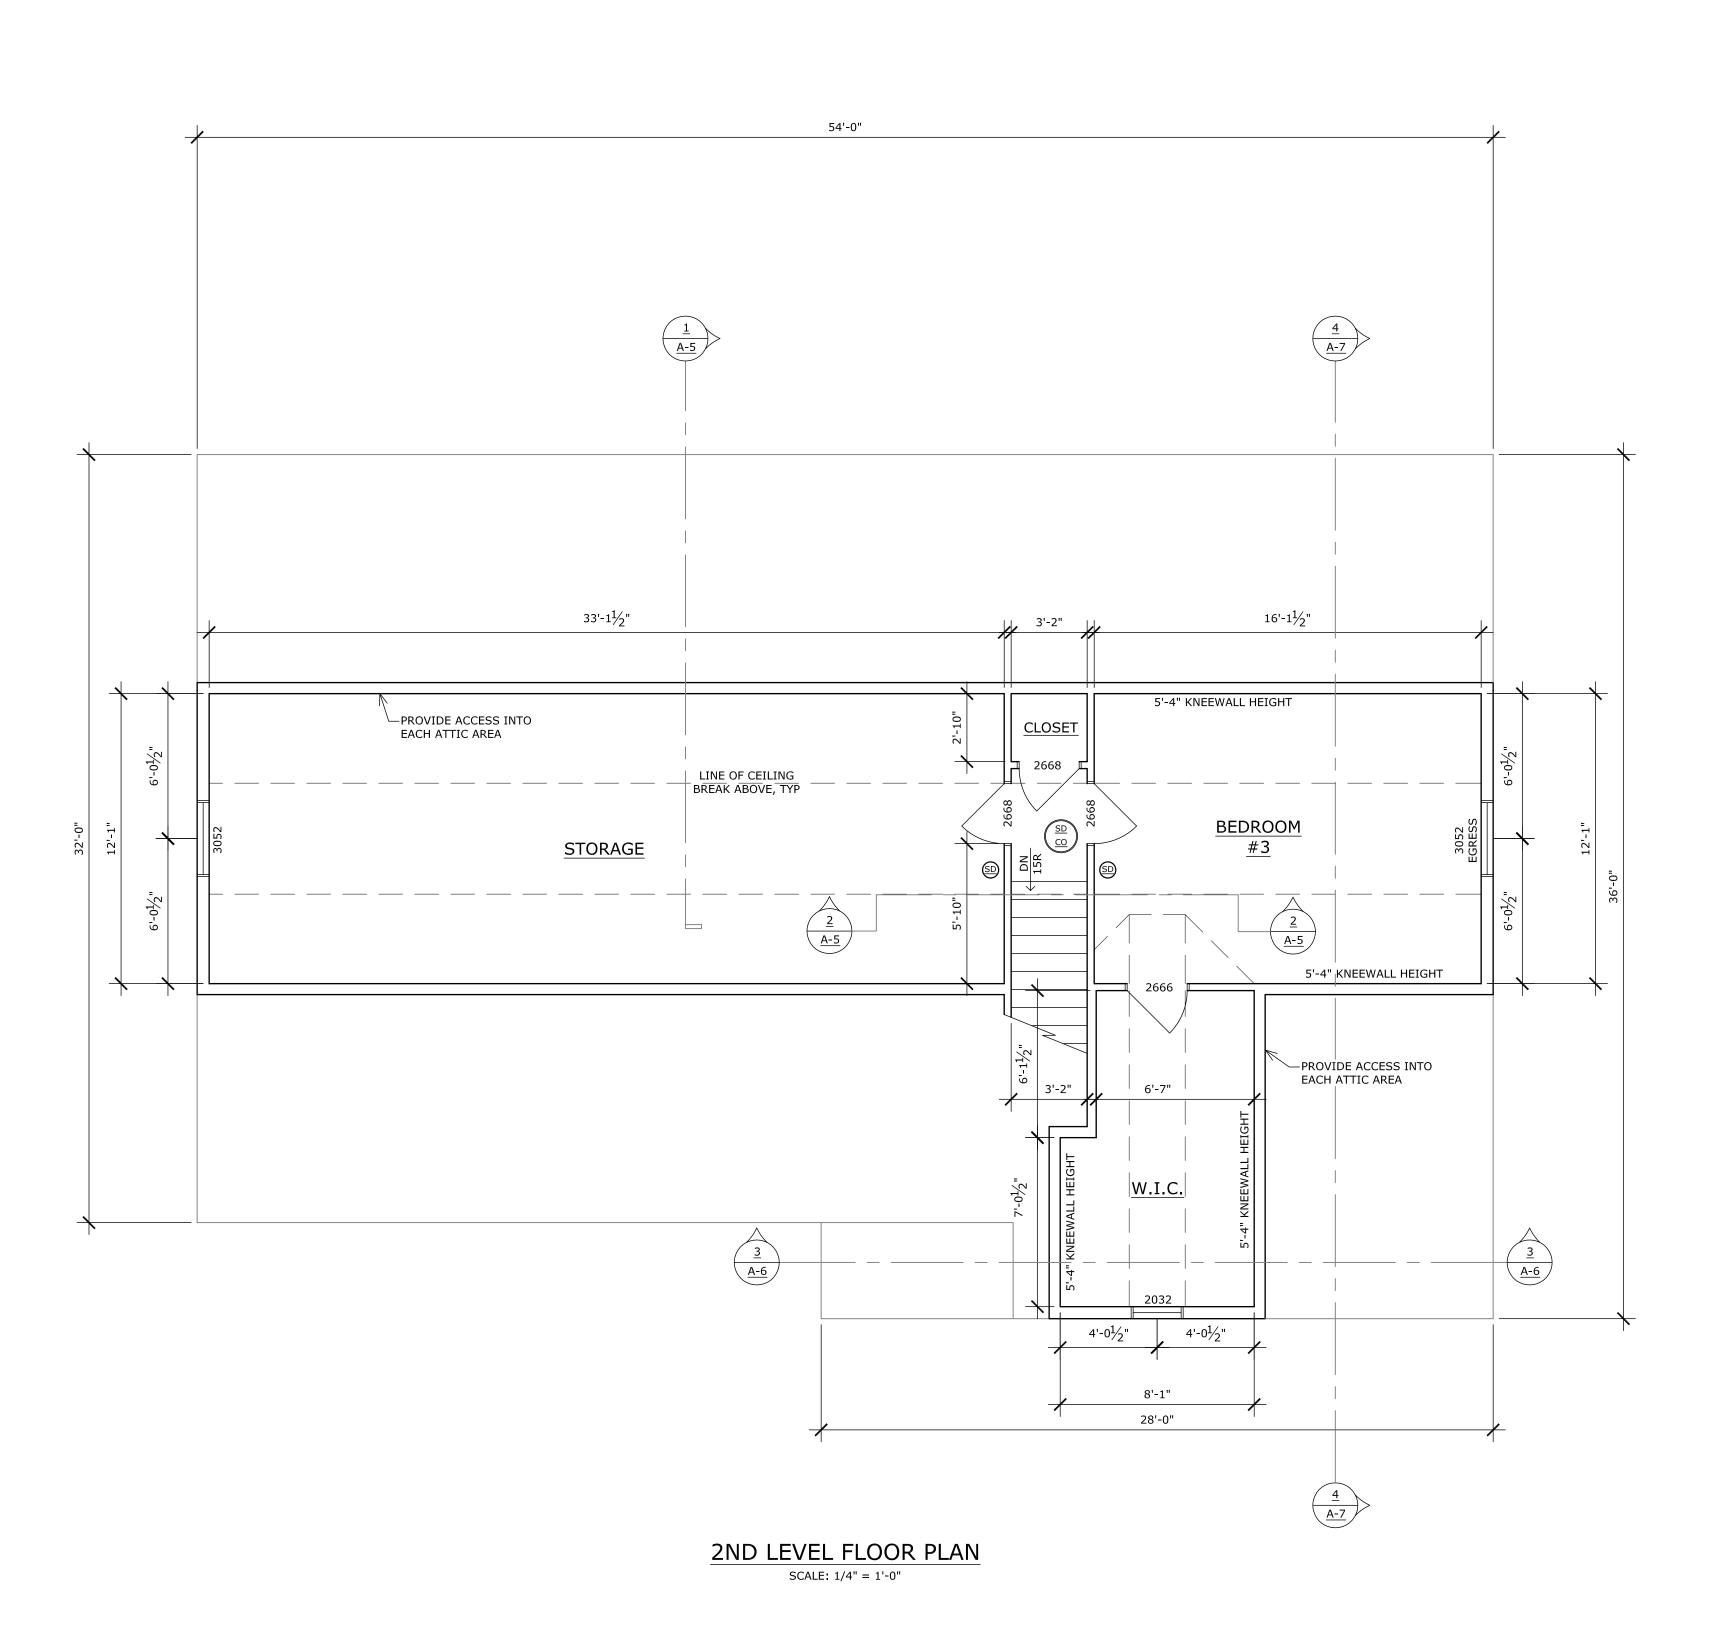

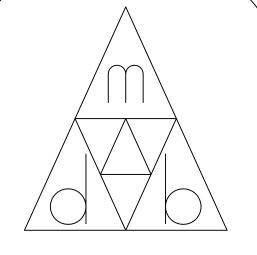

21153 main street shade gap, pa 17255 (814) 421-6233 www.mdbhouseplans.com

Client

Benjamin & Ann Good 14 Village Lane Harrisonville, PA 17228

Project


New Residence Benjamin & Ann Good Bear Valley Road Fort Loudon, PA 17224


Drawing


2nd Level Floor Plan

Sheet Number

A-4

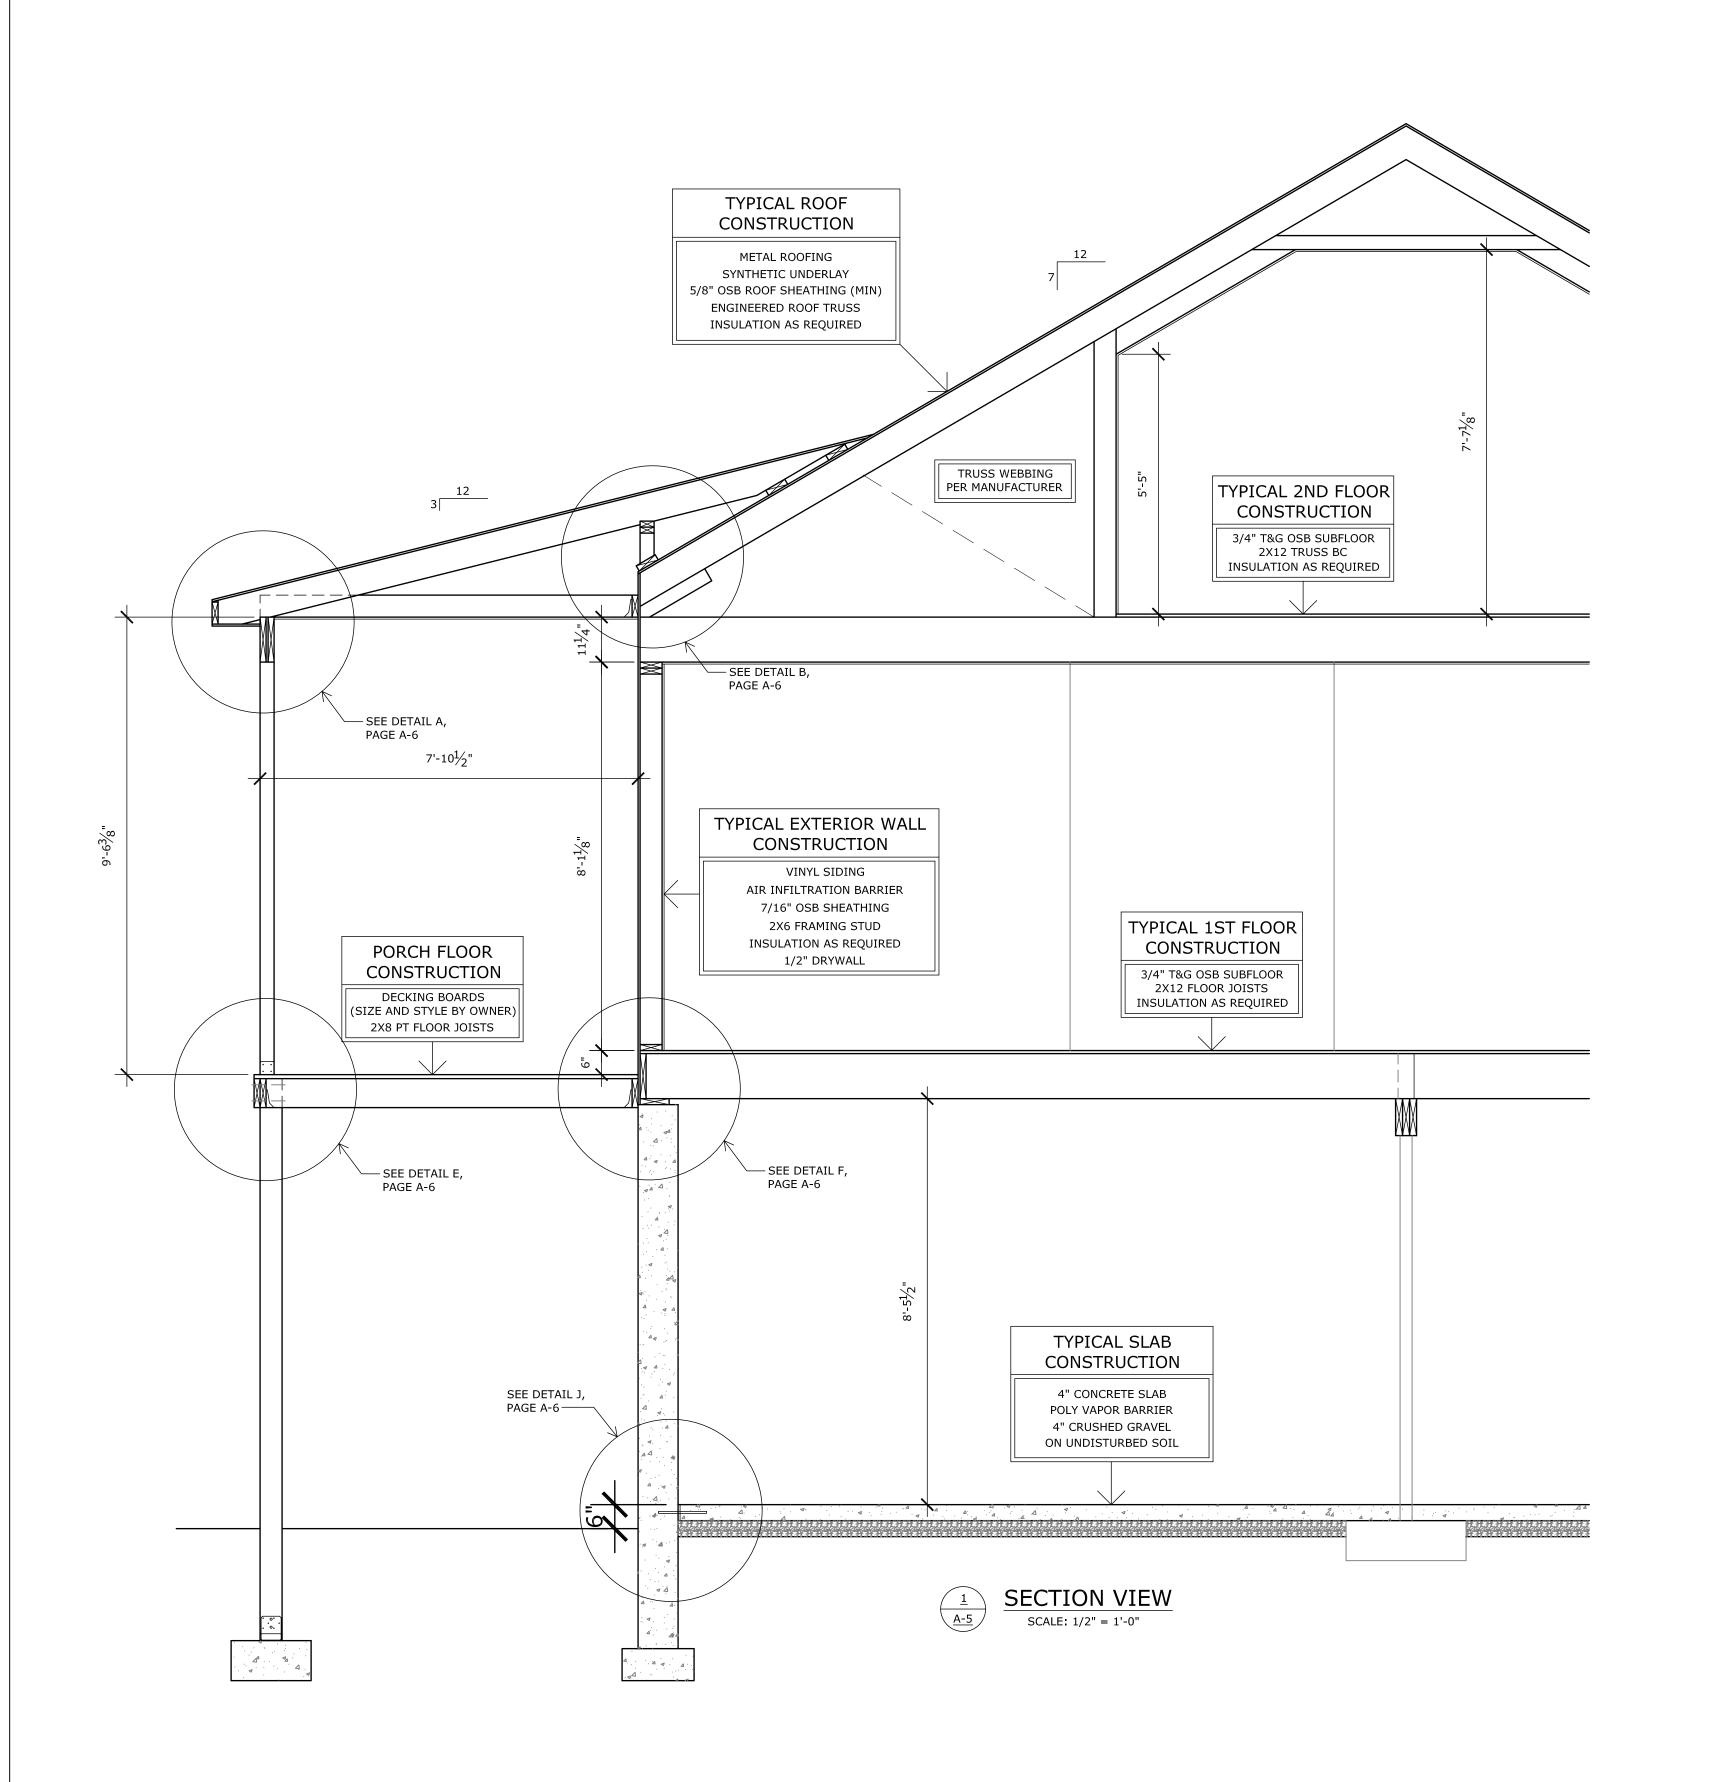

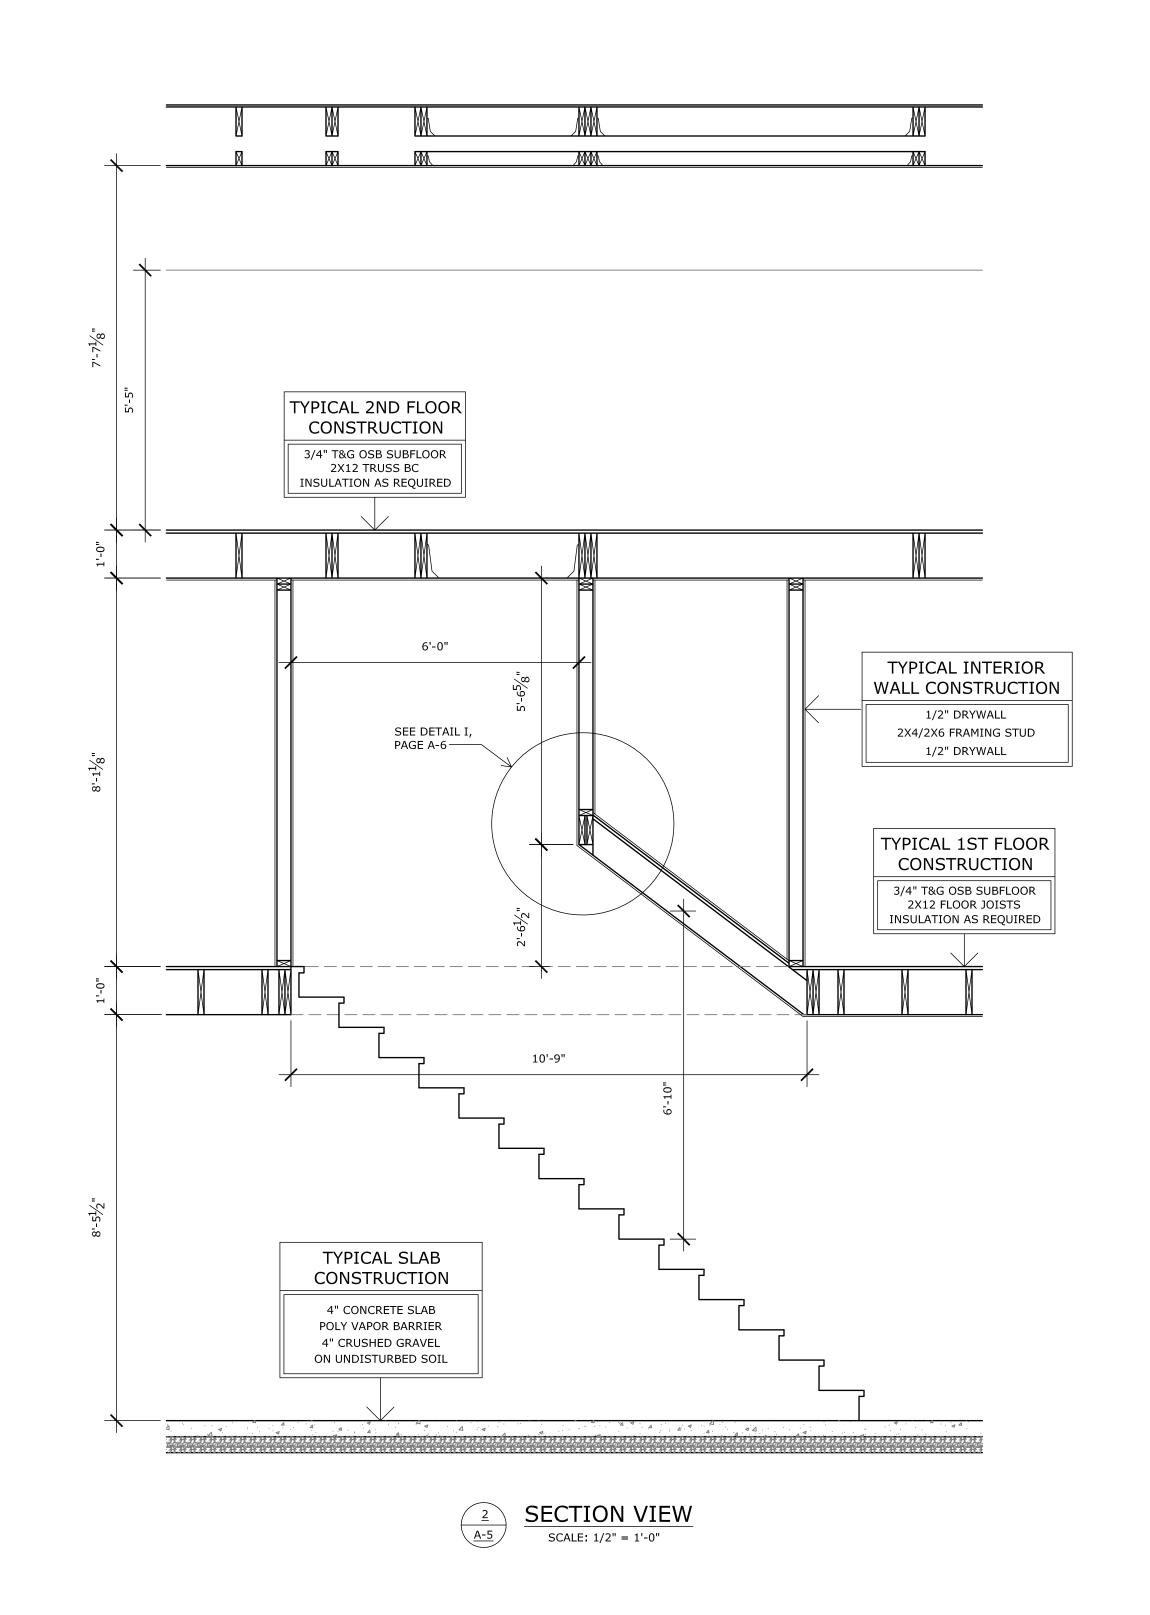

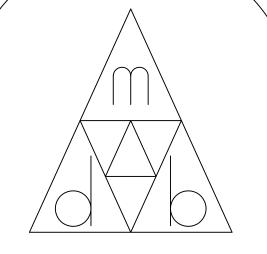

21153 main street shade gap, pa 17255 (814) 421-6233 www.mdbhouseplans.com

Client

Benjamin & Ann Good 14 Village Lane Harrisonville, PA 17228

Project


New Residence Benjamin & Ann Good Bear Valley Road Fort Loudon, PA 17224


Drawing


Section Views

Sheet Number

A-5

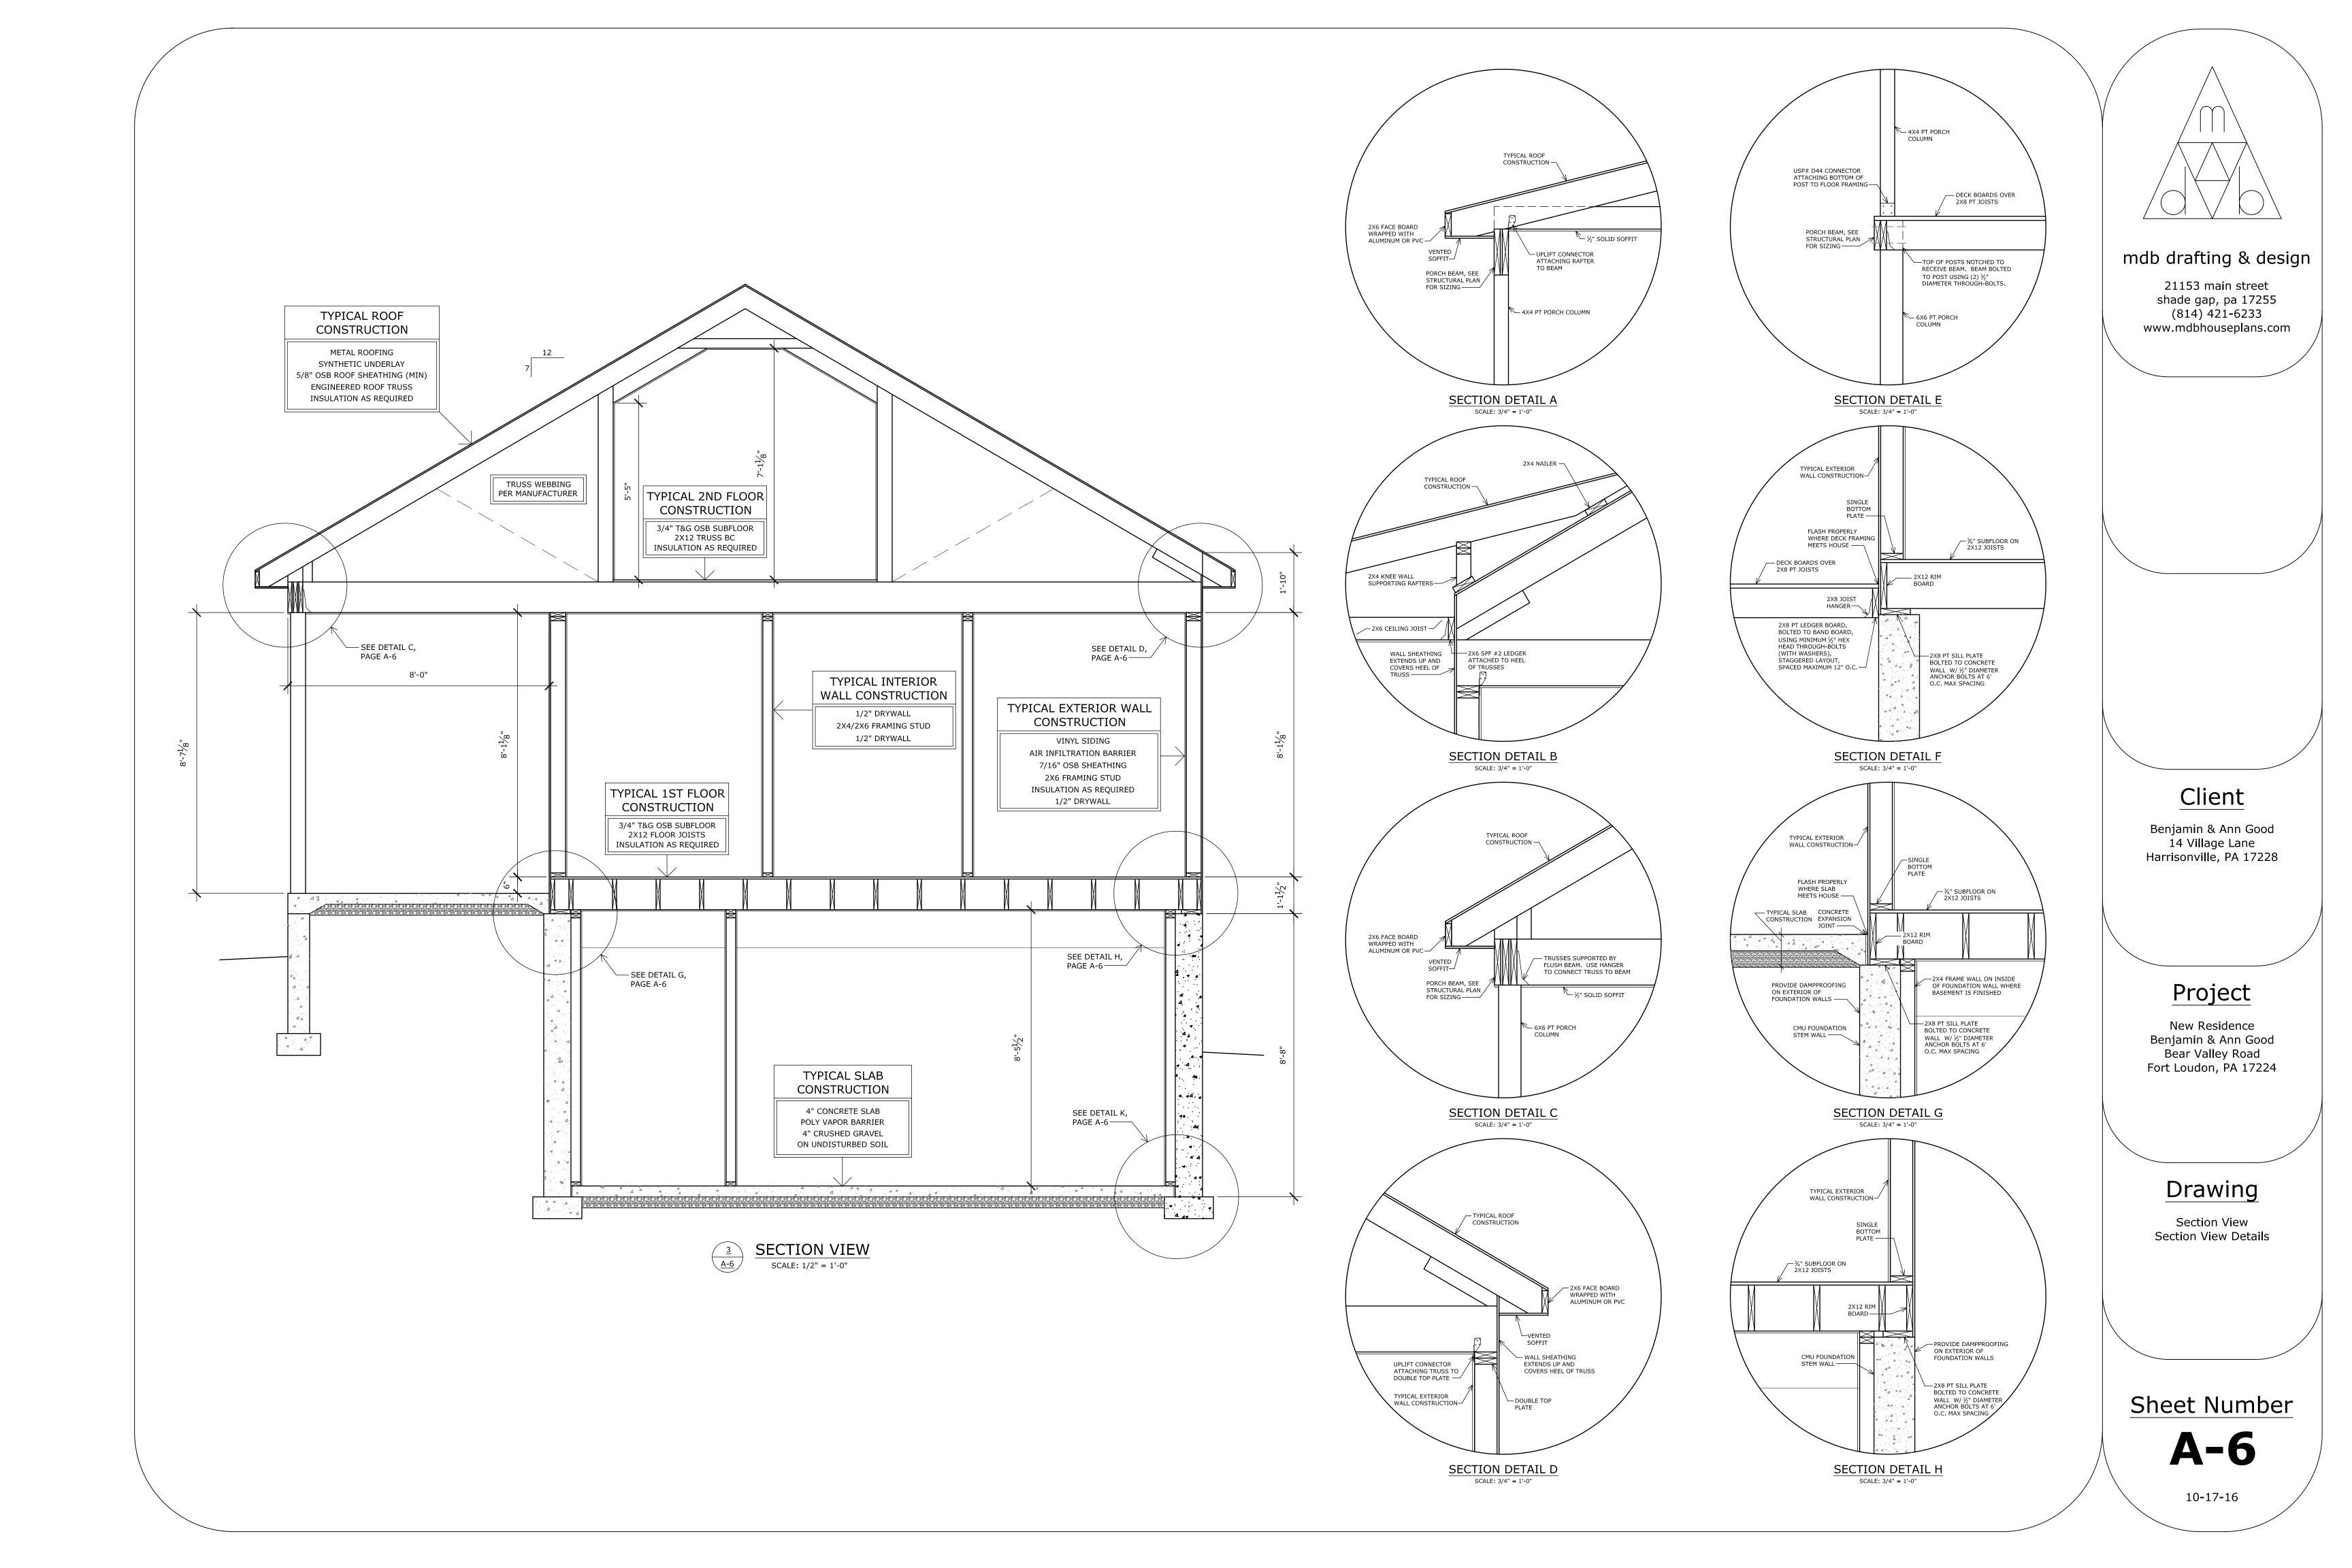

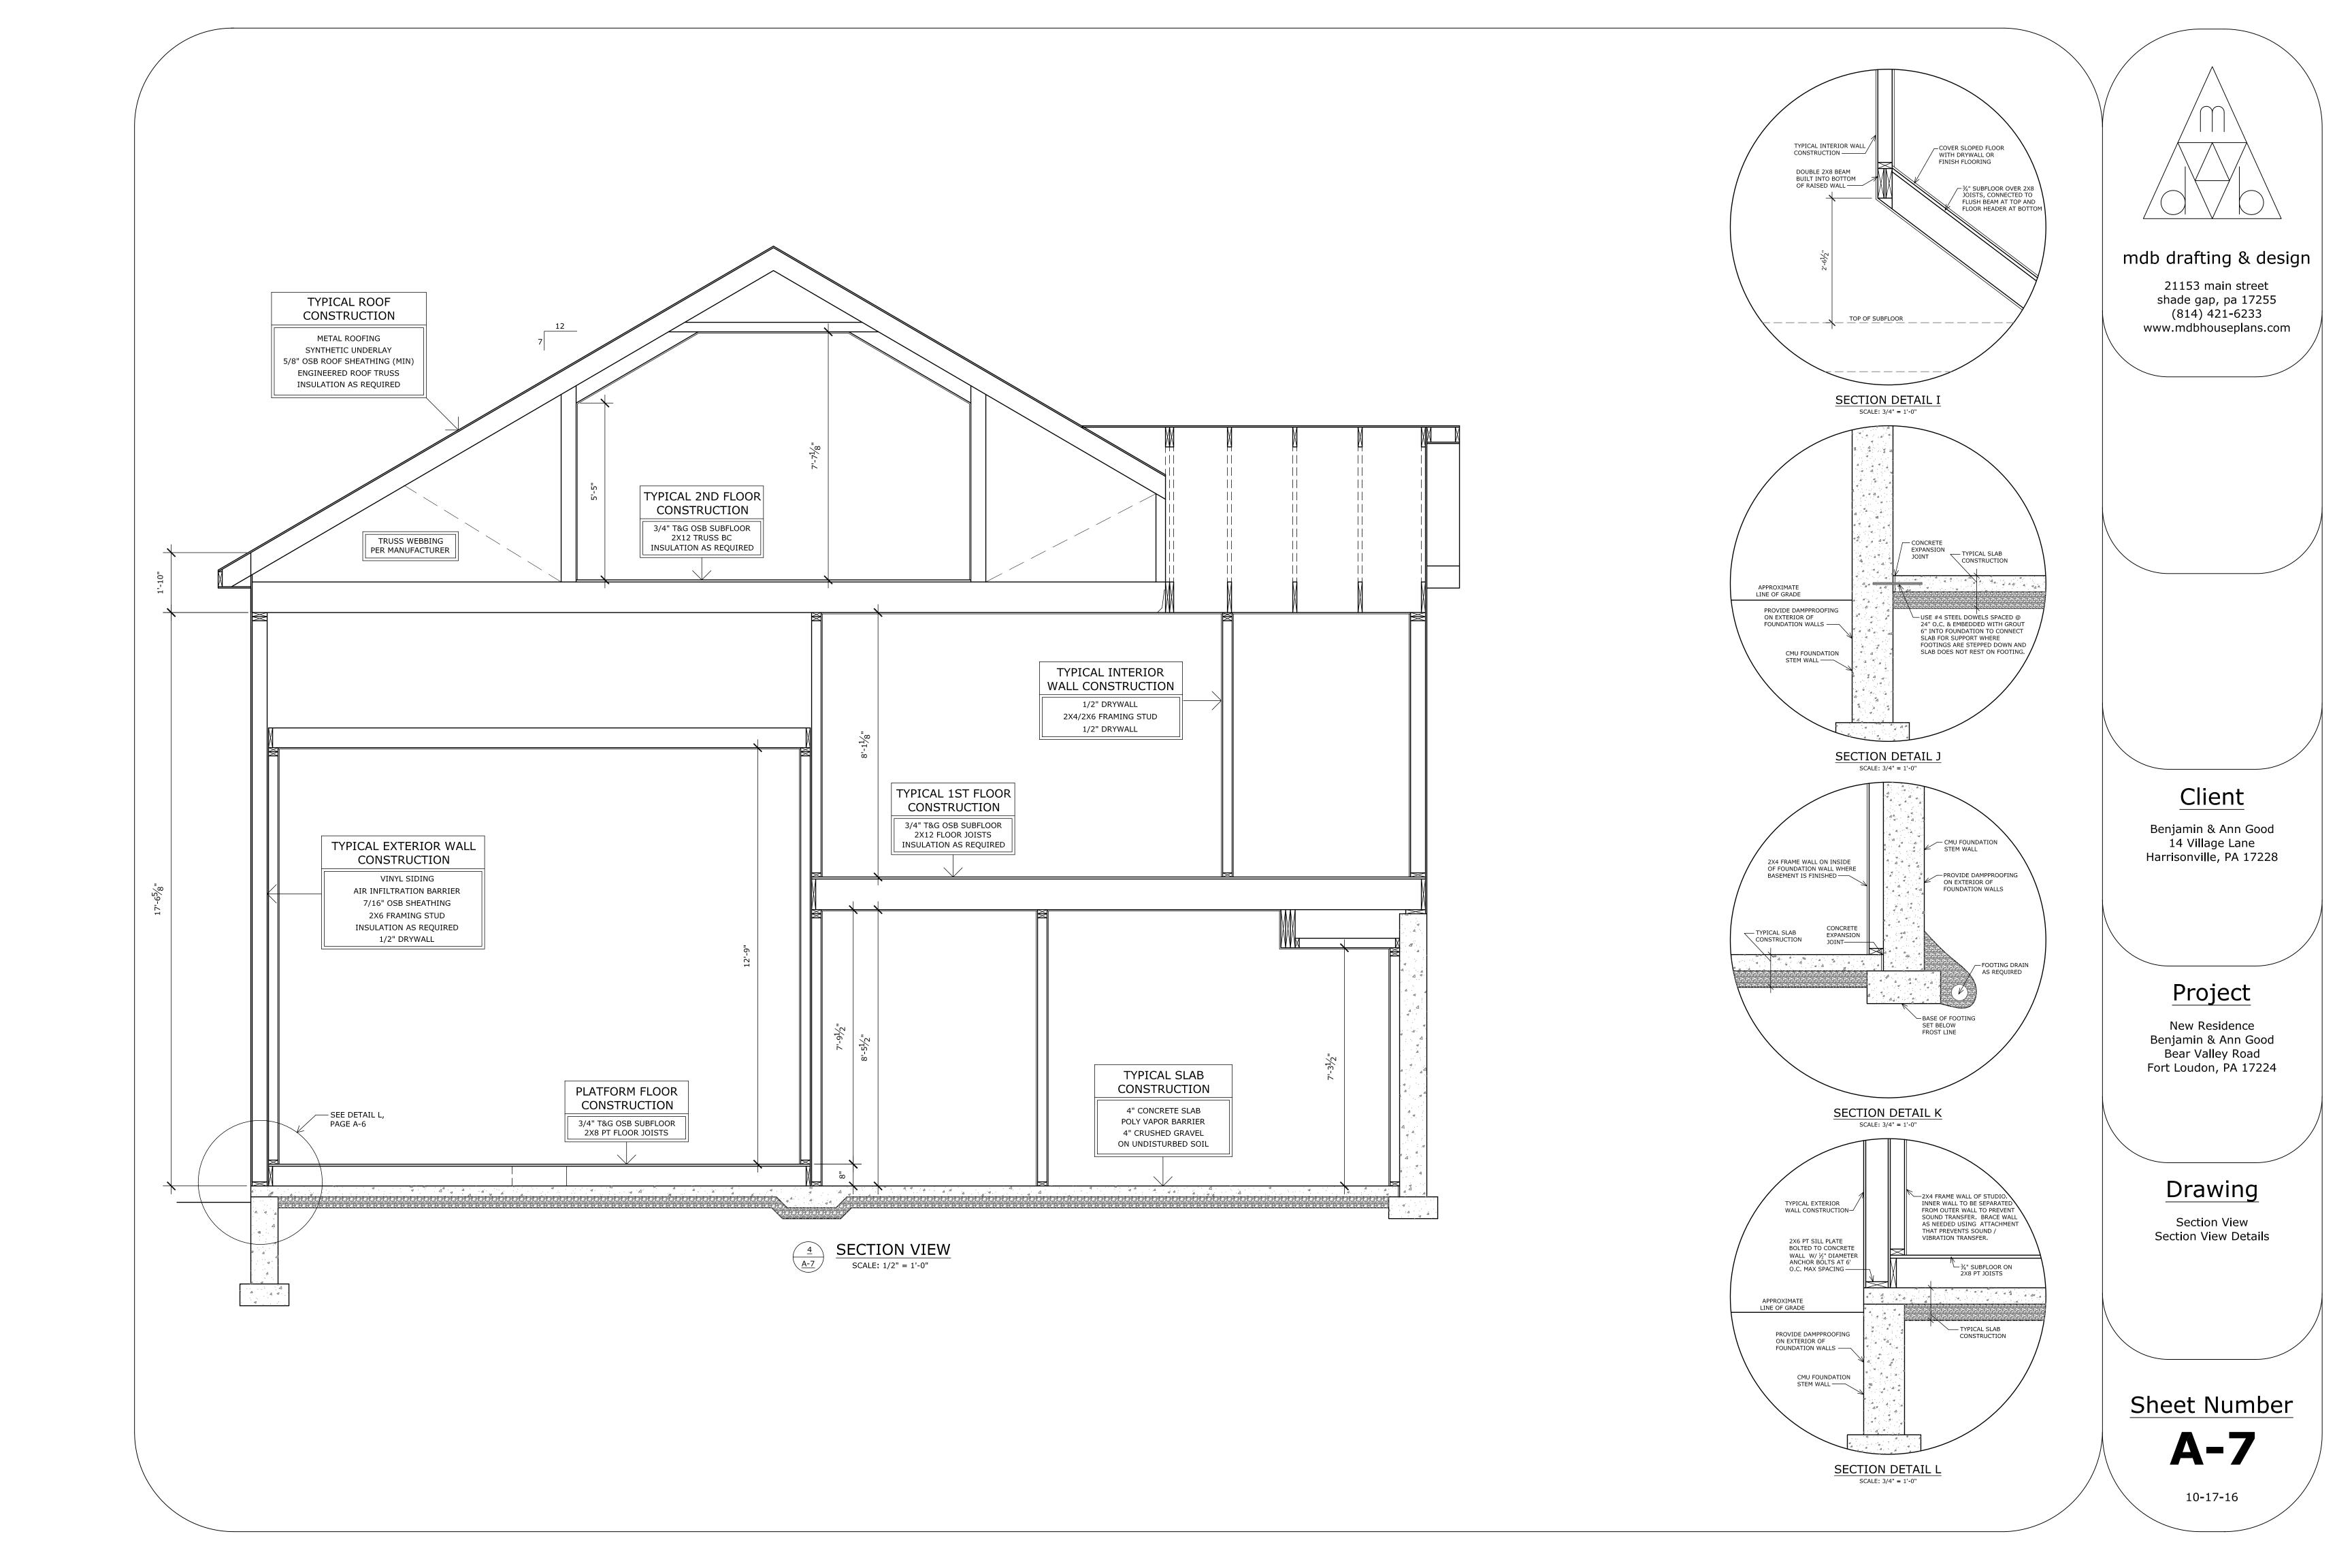

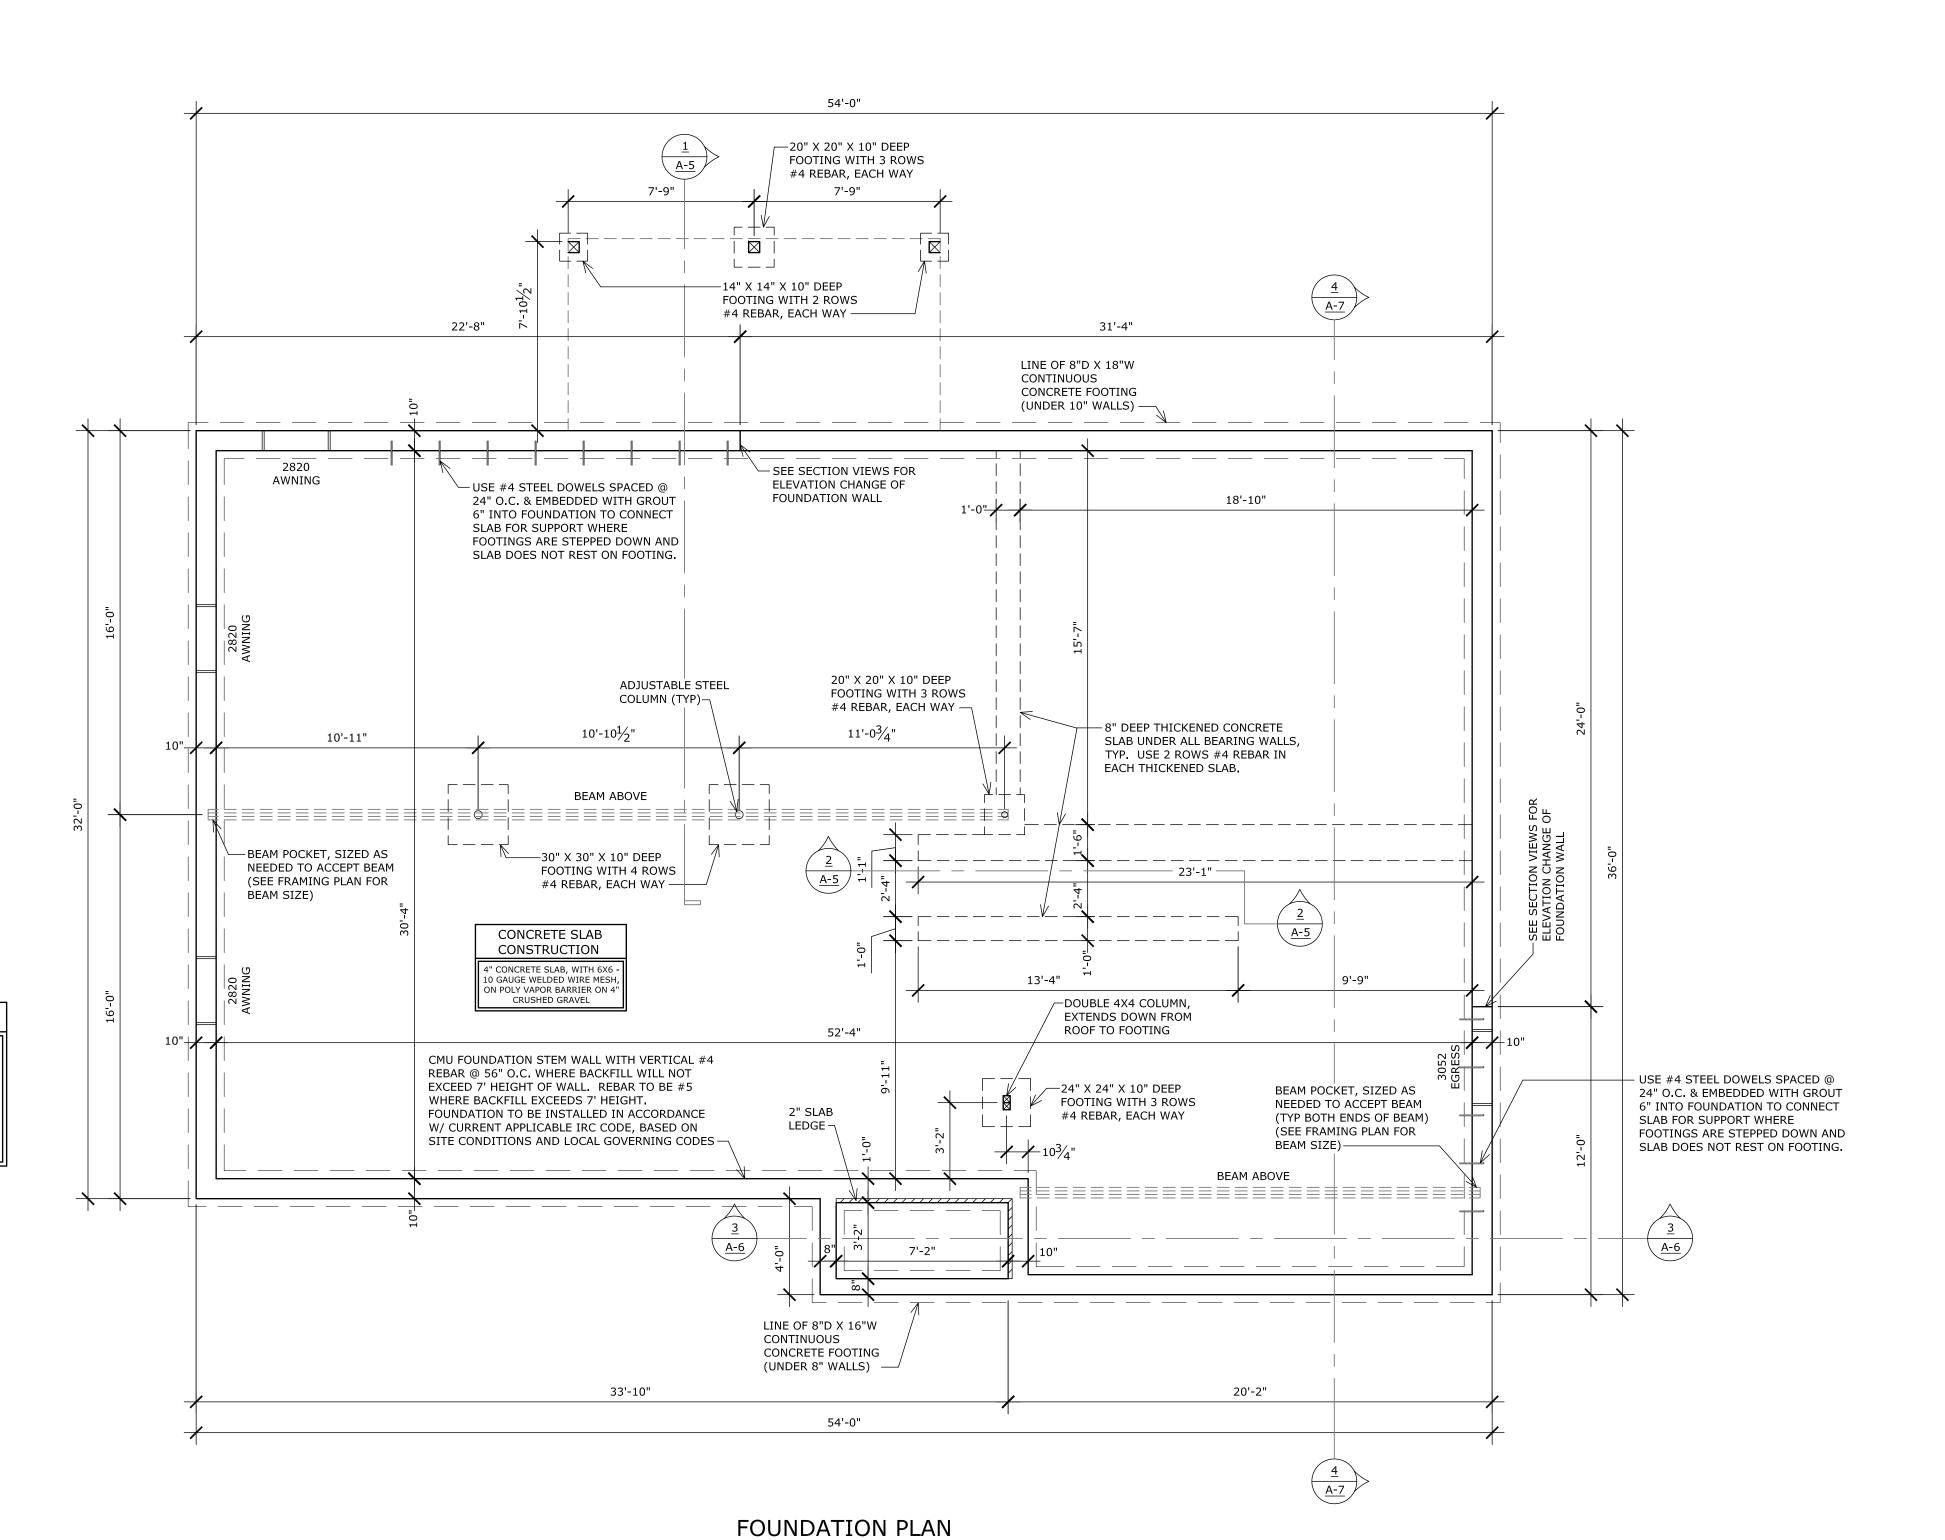

SCALE: 1/4" = 1'-0"

NOTE: SILL PLATE ANCHOR BOLTS
SHALL BE MINIMUM ½" DIAMETER,
SPACED AT MAXIMUM 6' O.C., WITH
BOLTS NO LESS THAN 12" FROM
CORNERS OR ENDS OF PLATE SPLICES.

FOUNDATION PLAN NOTES

1) CONCRETE COMPRESSIVE STRENGTH TO BE MINIMUM 3000 PSI.

2) ASSUMED SOIL BEARING PRESSURE IS 2000 PSF.3) STEP FOOTINGS AS REQUIRED TO MAINTAIN PROPER FROST LINE DEPTH.

Bear Valley Road Fort Loudon, PA 17224

Project

New Residence

Benjamin & Ann Good

Client

Benjamin & Ann Good 14 Village Lane

Harrisonville, PA 17228

mdb drafting & design

21153 main street

shade gap, pa 17255 (814) 421-6233


www.mdbhouseplans.com

Drawing

Foundation Plan

Sheet Number

S-1

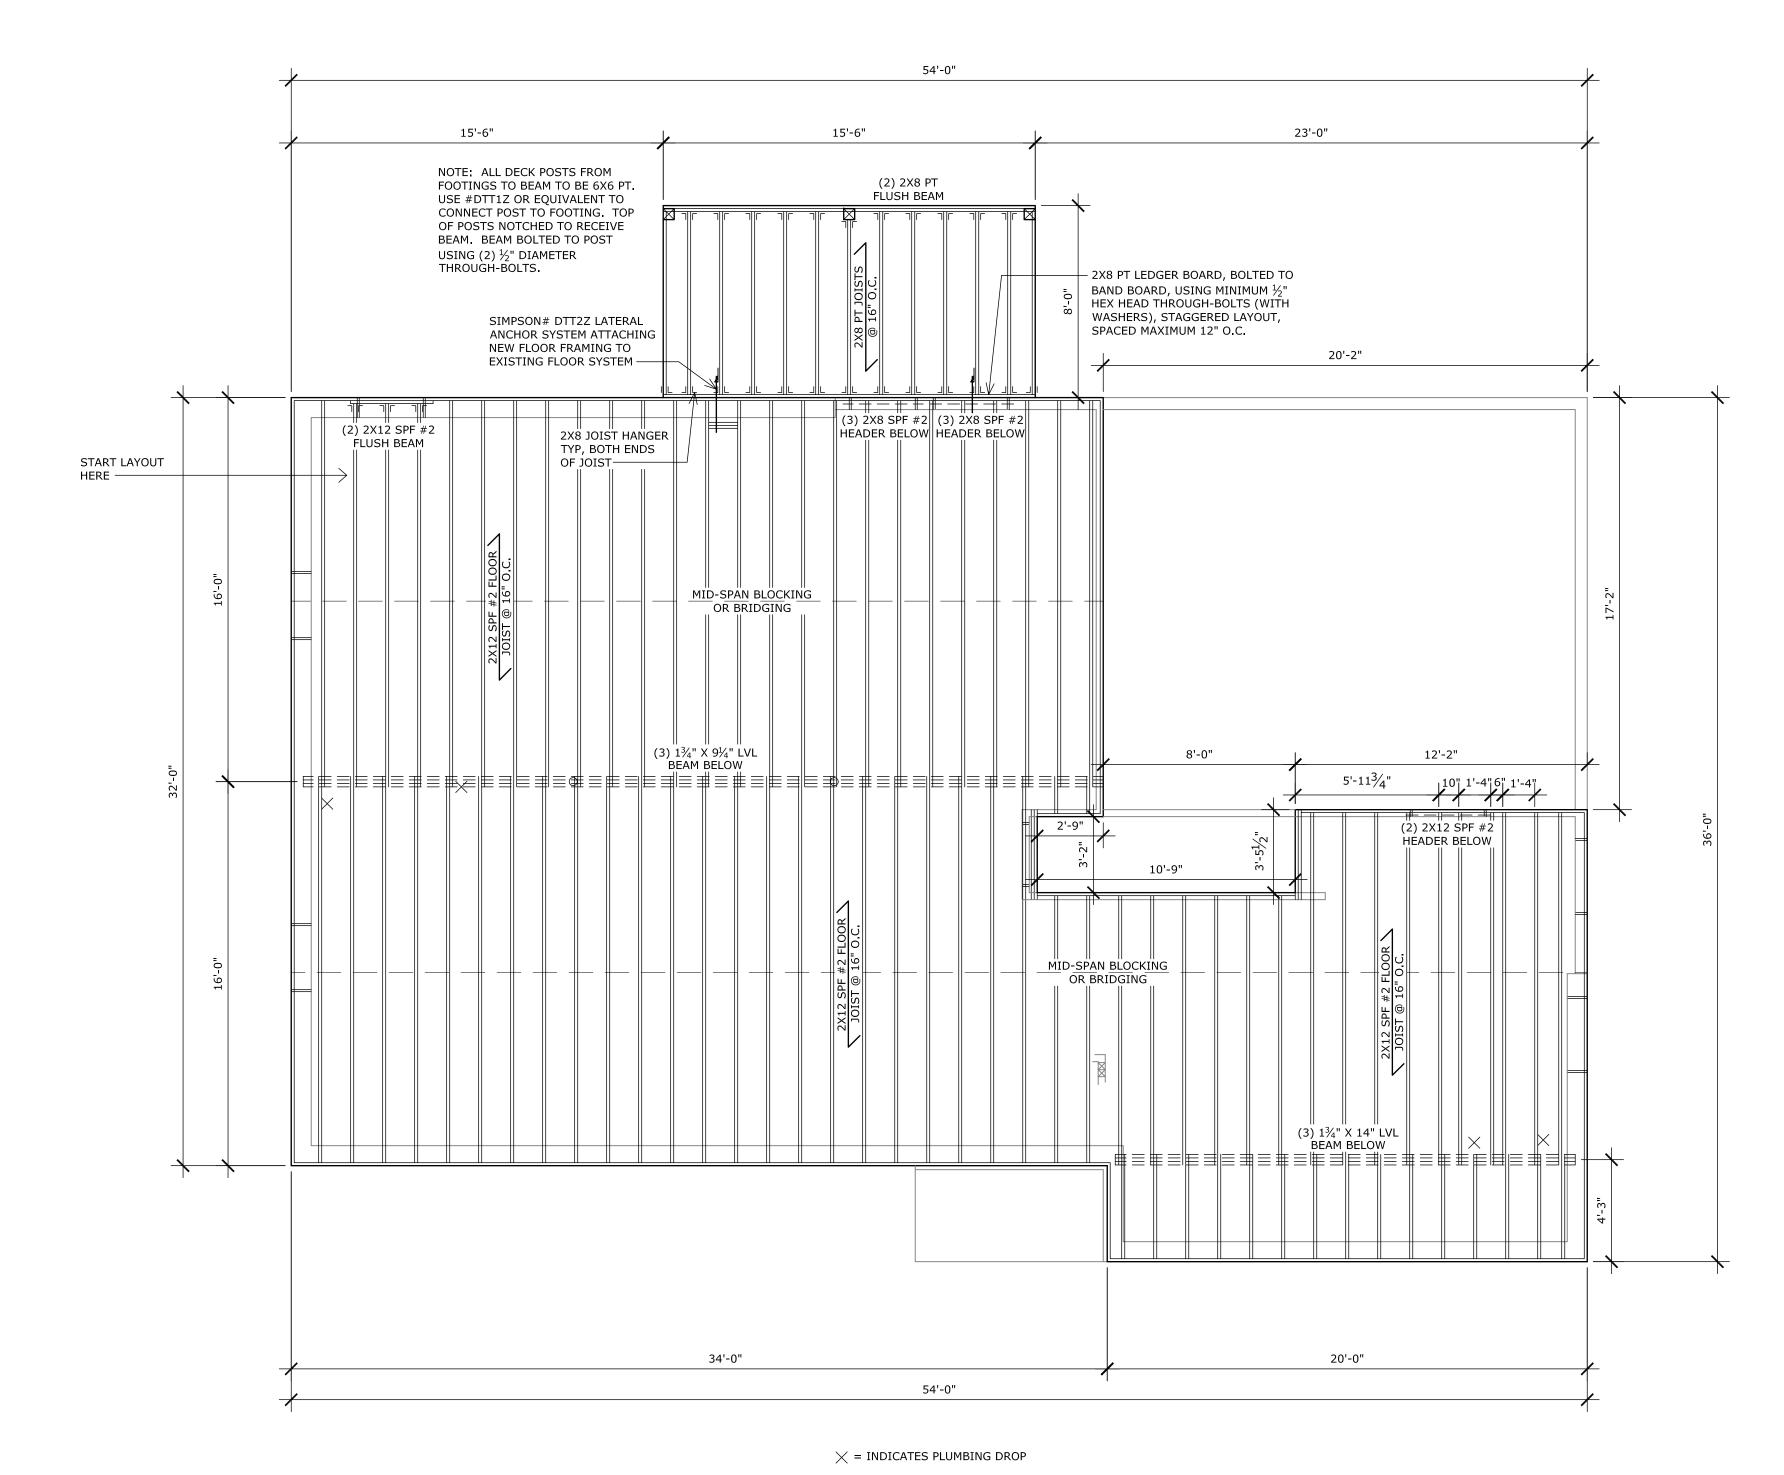

FLOOR FRAMING NOTES

1) 2X12 BAND BOARD AROUND PERIMETER OF FLOOR DECK AND AT STAIRS.


2) USE PROPER HANGERS/CONNECTED WHERE

3) INSTALL BLOCKING UNDER PARALLEL PARTITION WALLS SITTING ON FLOOR DECK.

4) INSTALL VERTICAL BLOCKING UNDER COLUMNS. POSTING TO BE CONTINUOUS DOWN TO FOUNDATION.

1ST LEVEL FLOOR FRAMING PLAN

SCALE: 1/4" = 1'-0"

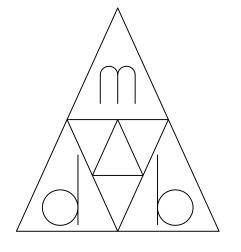

mdb drafting & design

21153 main street shade gap, pa 17255 (814) 421-6233 www.mdbhouseplans.com

Client

Benjamin & Ann Good 14 Village Lane Harrisonville, PA 17228

Project


New Residence Benjamin & Ann Good Bear Valley Road Fort Loudon, PA 17224


<u>Drawing</u>

1st Level Floor Framing Plan

Sheet Number

S-2

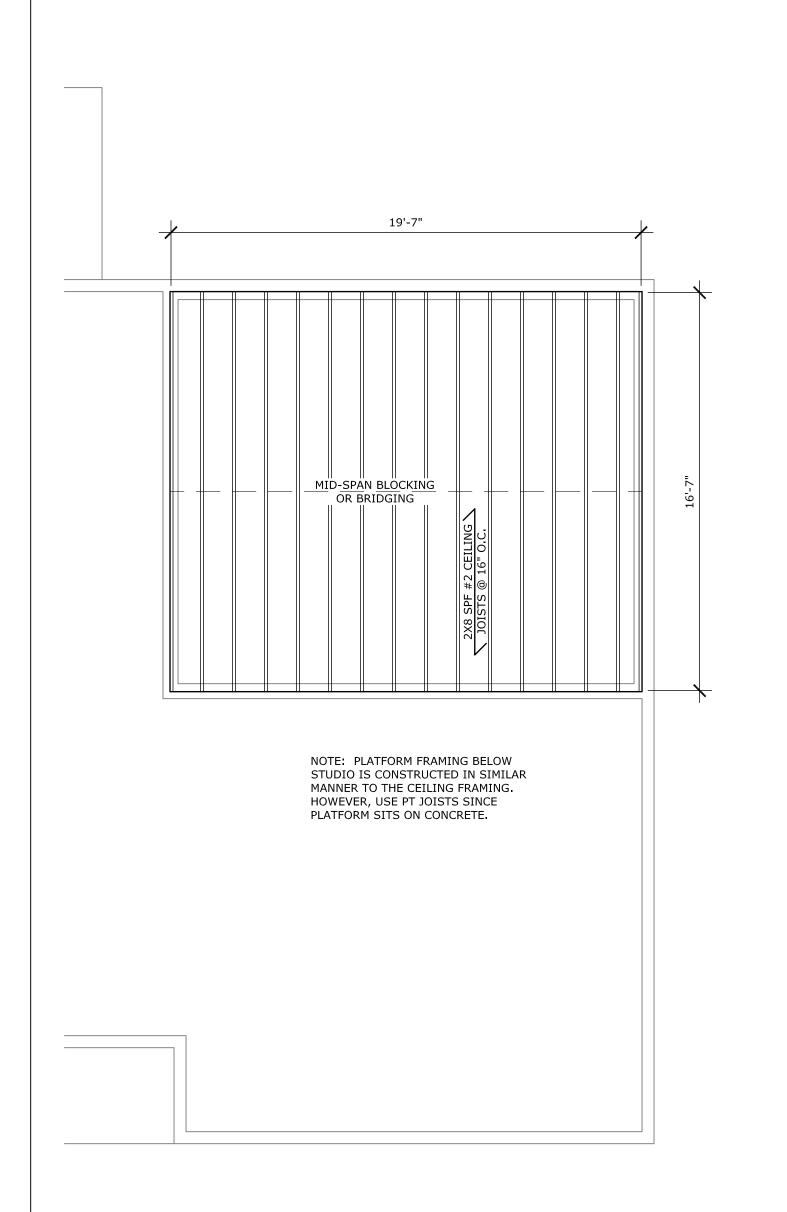

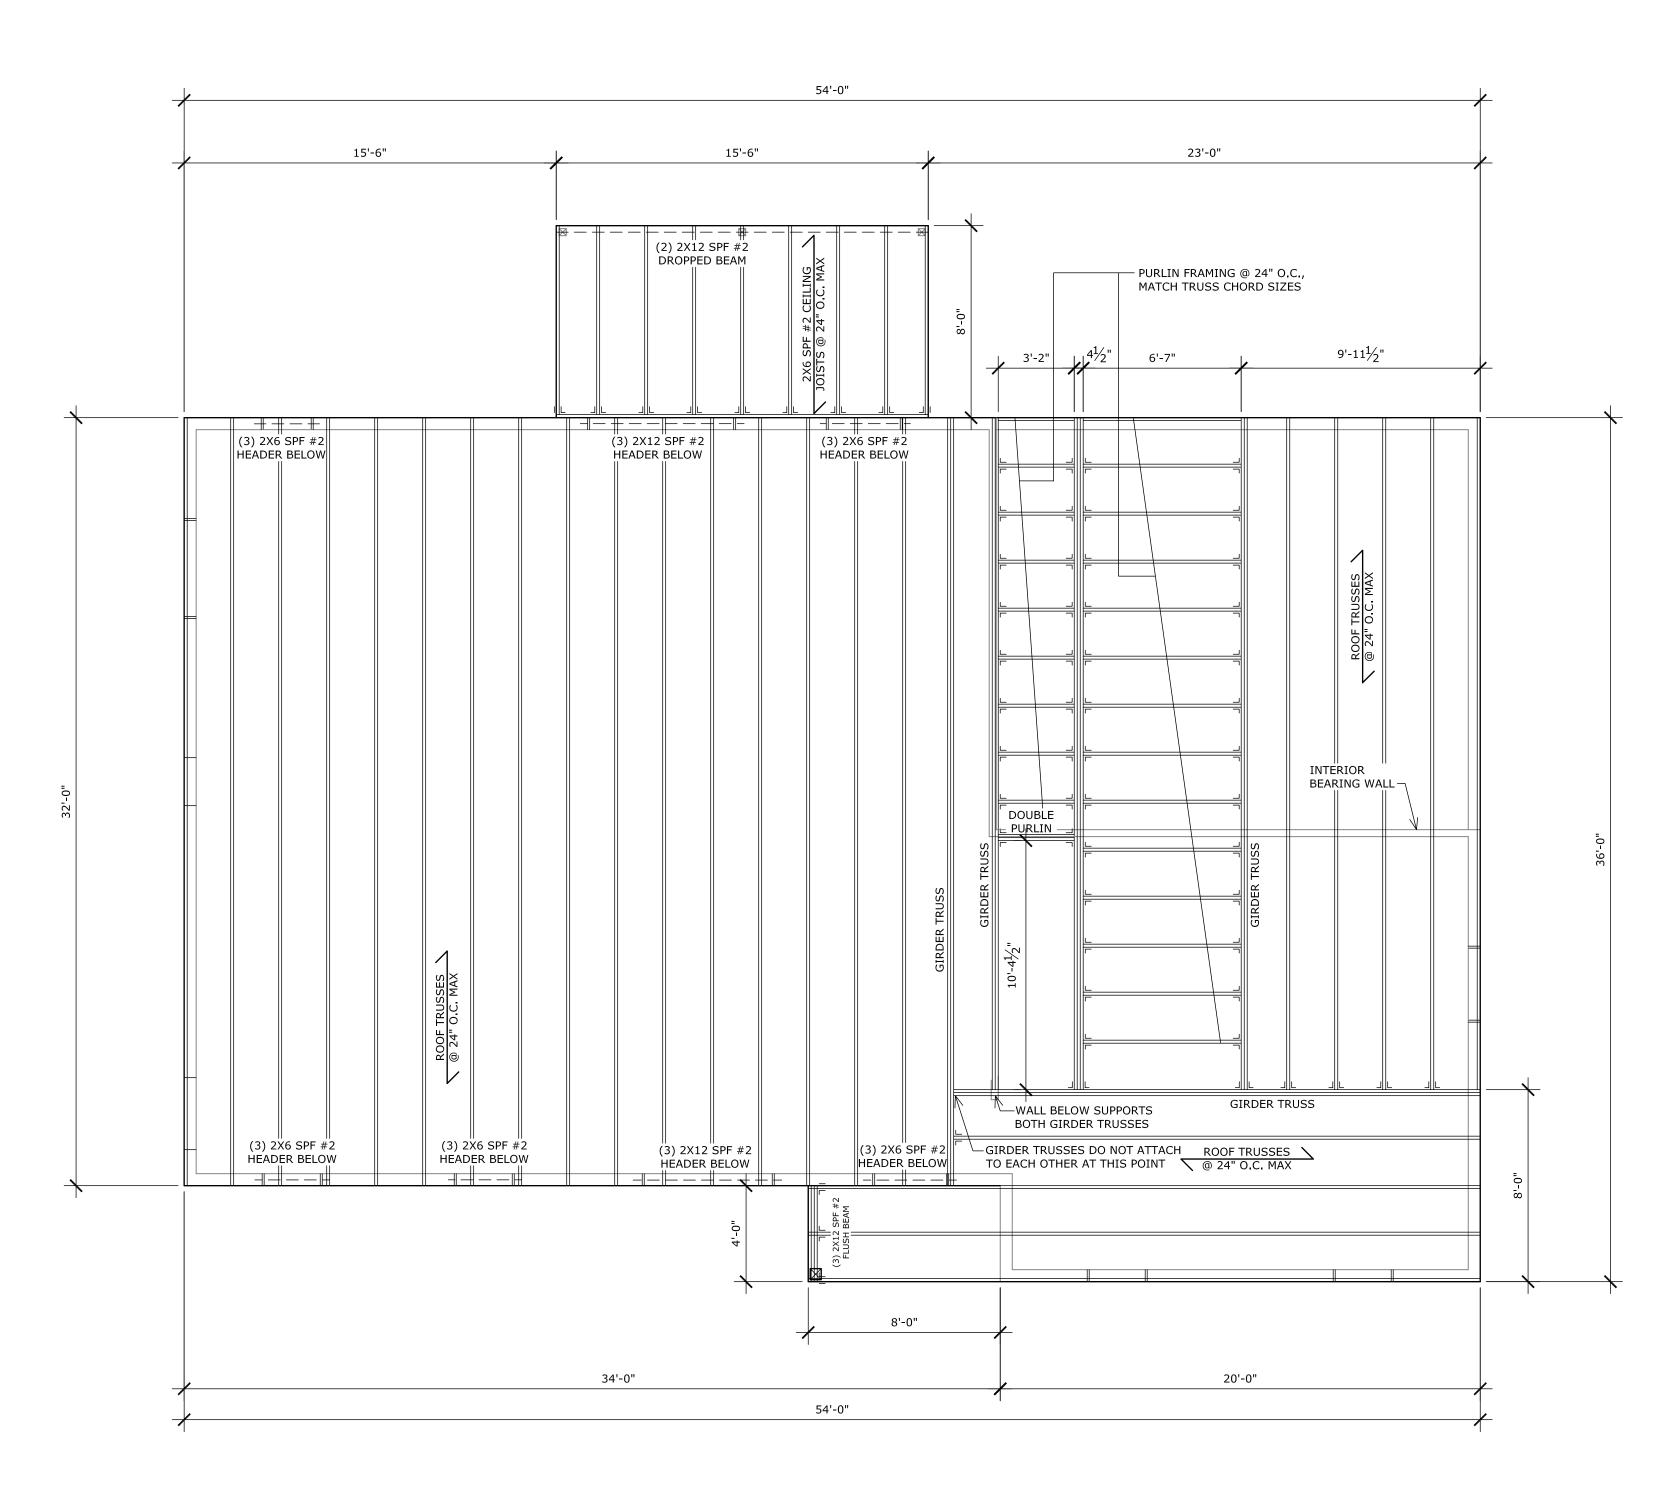

CEILING FRAMING OVER STUDIO

SCALE: 1/4" = 1'-0"

2ND LEVEL FLOOR FRAMING PLAN

SCALE: 1/4" = 1'-0"

NOTE: 1' OVERHANG ALL SIDES.

ROOF FRAMING NOTES

1) USE PROPER HANGERS/CONNECTORS WHERE NEEDED.


4) USE OSB OR PLYWOOD FILLER FOR ALL HEADERS WHERE NECESSARY.

5) ALL HEADERS OVER WINDOWS AND DOORS TO BE SET AT 6'-107%" ABOVE MAIN LEVEL SUBFLOOR, UNLESS SPECIFIED OTHERWISE.

AS THEY SEE NECESSARY. TRUSS SUPPLIER TAKES FULL RESPONSIBILITY FOR CHANGES TO TRUSS LAYOUT, AND POSSIBLE RESULTING ISSUES.

3) TRUSS BRACING TO BE INSTALLED PER SPECIFICATIONS OF TRUSS SUPPLIER.

7) 2X6 FACE BOARD AT ALL EAVE LINES, 2X6 LADDERS ON ALL GABLES.

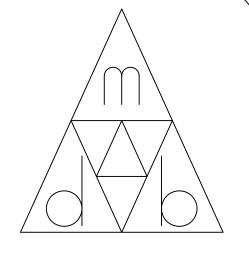

mdb drafting & design

21153 main street shade gap, pa 17255 (814) 421-6233 www.mdbhouseplans.com

Client

Benjamin & Ann Good 14 Village Lane Harrisonville, PA 17228

Project


New Residence Benjamin & Ann Good Bear Valley Road Fort Loudon, PA 17224

Drawing

2nd Level Floor Framing Plan Ceiling Framing Over Studio

Sheet Number

S-3

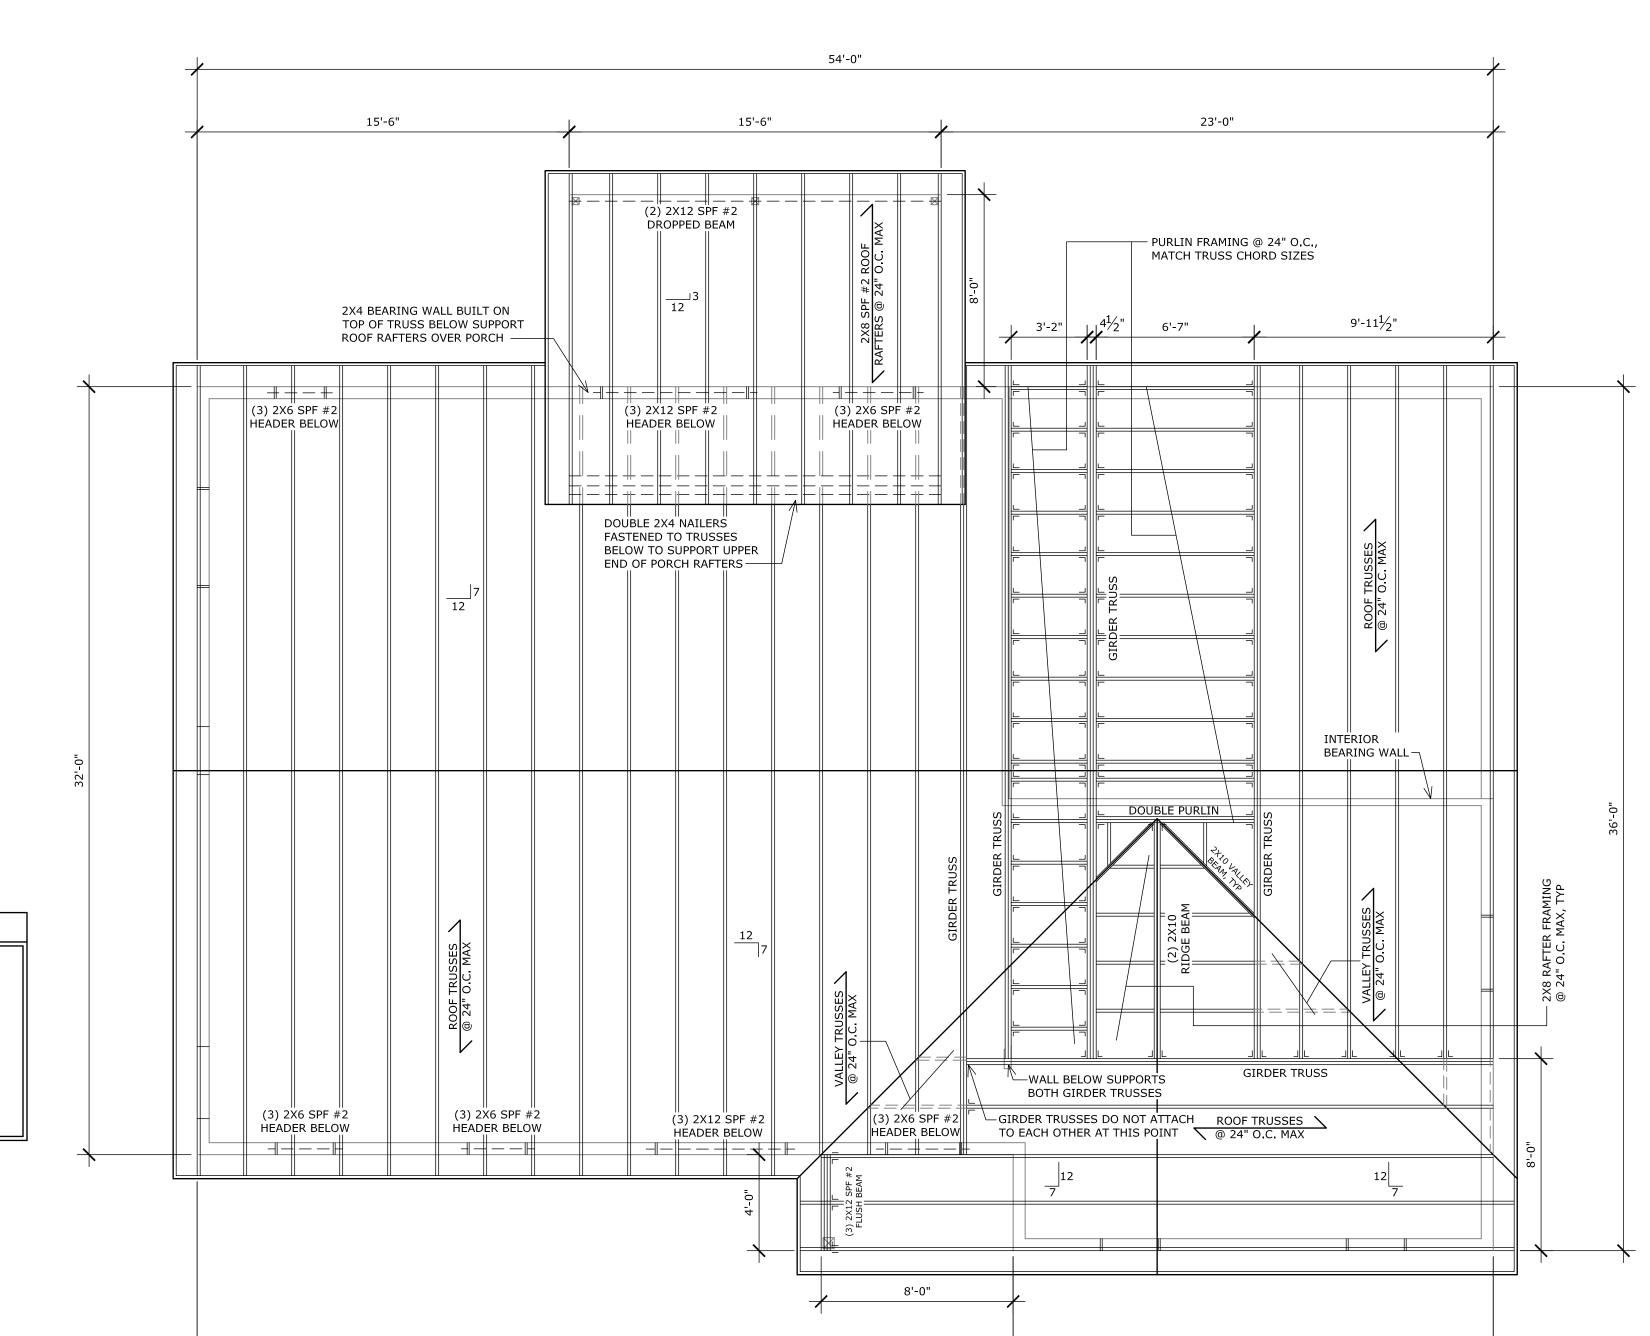

NOTE: 1' OVERHANG ALL SIDES.

ROOF FRAMING NOTES

USE PROPER HANGERS/CONNECTORS WHERE NEEDED.

2) TRUSS LAYOUT SHOWN IS BEST SUGGESTION BASED ON DESIGN OF STRUCTURE. VARIATIONS TO THE TRUSS LAYOUT MAY BE MADE BY TRUSS SUPPLIER AS THEY SEE NECESSARY. TRUSS SUPPLIER TAKES FULL RESPONSIBILITY FOR CHANGES TO TRUSS

3) TRUSS BRACING TO BE INSTALLED PER SPECIFICATIONS OF TRUSS SUPPLIER.

LAYOUT, AND POSSIBLE RESULTING ISSUES.

4) USE OSB OR PLYWOOD FILLER FOR ALL HEADERS WHERE NECESSARY.

5) ALL HEADERS OVER WINDOWS AND DOORS TO BE SET AT 6'-10%" ABOVE MAIN LEVEL SUBFLOOR, UNLESS SPECIFIED OTHERWISE.

6) ALL HEADER SIZES SHOWN ARE MINIMUM SIZES, AND CAN BE INCREASED IF DESIRED.

AND CAN BE INCREASED IF DESIRED.

7) 2X6 FACE BOARD AT ALL EAVE LINES, 2X6 LADDERS ON ALL GABLES.

ROOF FRAMING PLAN

SCALE: 1/4" = 1'-0"

54'-0"

20'-0"

34'-0"

mdb drafting & design

21153 main street shade gap, pa 17255 (814) 421-6233 www.mdbhouseplans.com

Client

Benjamin & Ann Good 14 Village Lane Harrisonville, PA 17228

Project

New Residence Benjamin & Ann Good Bear Valley Road Fort Loudon, PA 17224

Drawing

Roof Framing Plan

Sheet Number

S-4